## PROPOSED MIXED USE DEVELOPMENT 14-22 MARY STREET, AUBURN STORMWATER CONCEPT DESIGN



		DRAWINGS LIST	
SHEET No.	DWG No.	TITLE	REV
1	SW100	COVER SHEET	С
2	SW200	STORMWATER CONCEPT DESIGN - BASEMENT 4 PLAN	С
3	SW201	STORMWATER CONCEPT DESIGN - GROUND FLOOR PLAN	С
4	SW202	STORMWATER CONCEPT DESIGN - ROOF PLAN	С
5	SW201	STORMWATER CONCEPT DESIGN - TRUNK MAIN DIVERSION - ULTIMATE STAGE	С
6	SW300	STORMWATER CONCEPT DESIGN - DETAILS - SHEET 1 OF 2	С
7	SW301	STORMWATER CONCEPT DESIGN - DETAILS - SHEET 2 OF 2	С
8	SW400	EROSION AND SEDIMENT CONTROL - PLAN AND DETAILS	С

LOCALITY PLAN

NOT TO SCALE



PREPARED BY:


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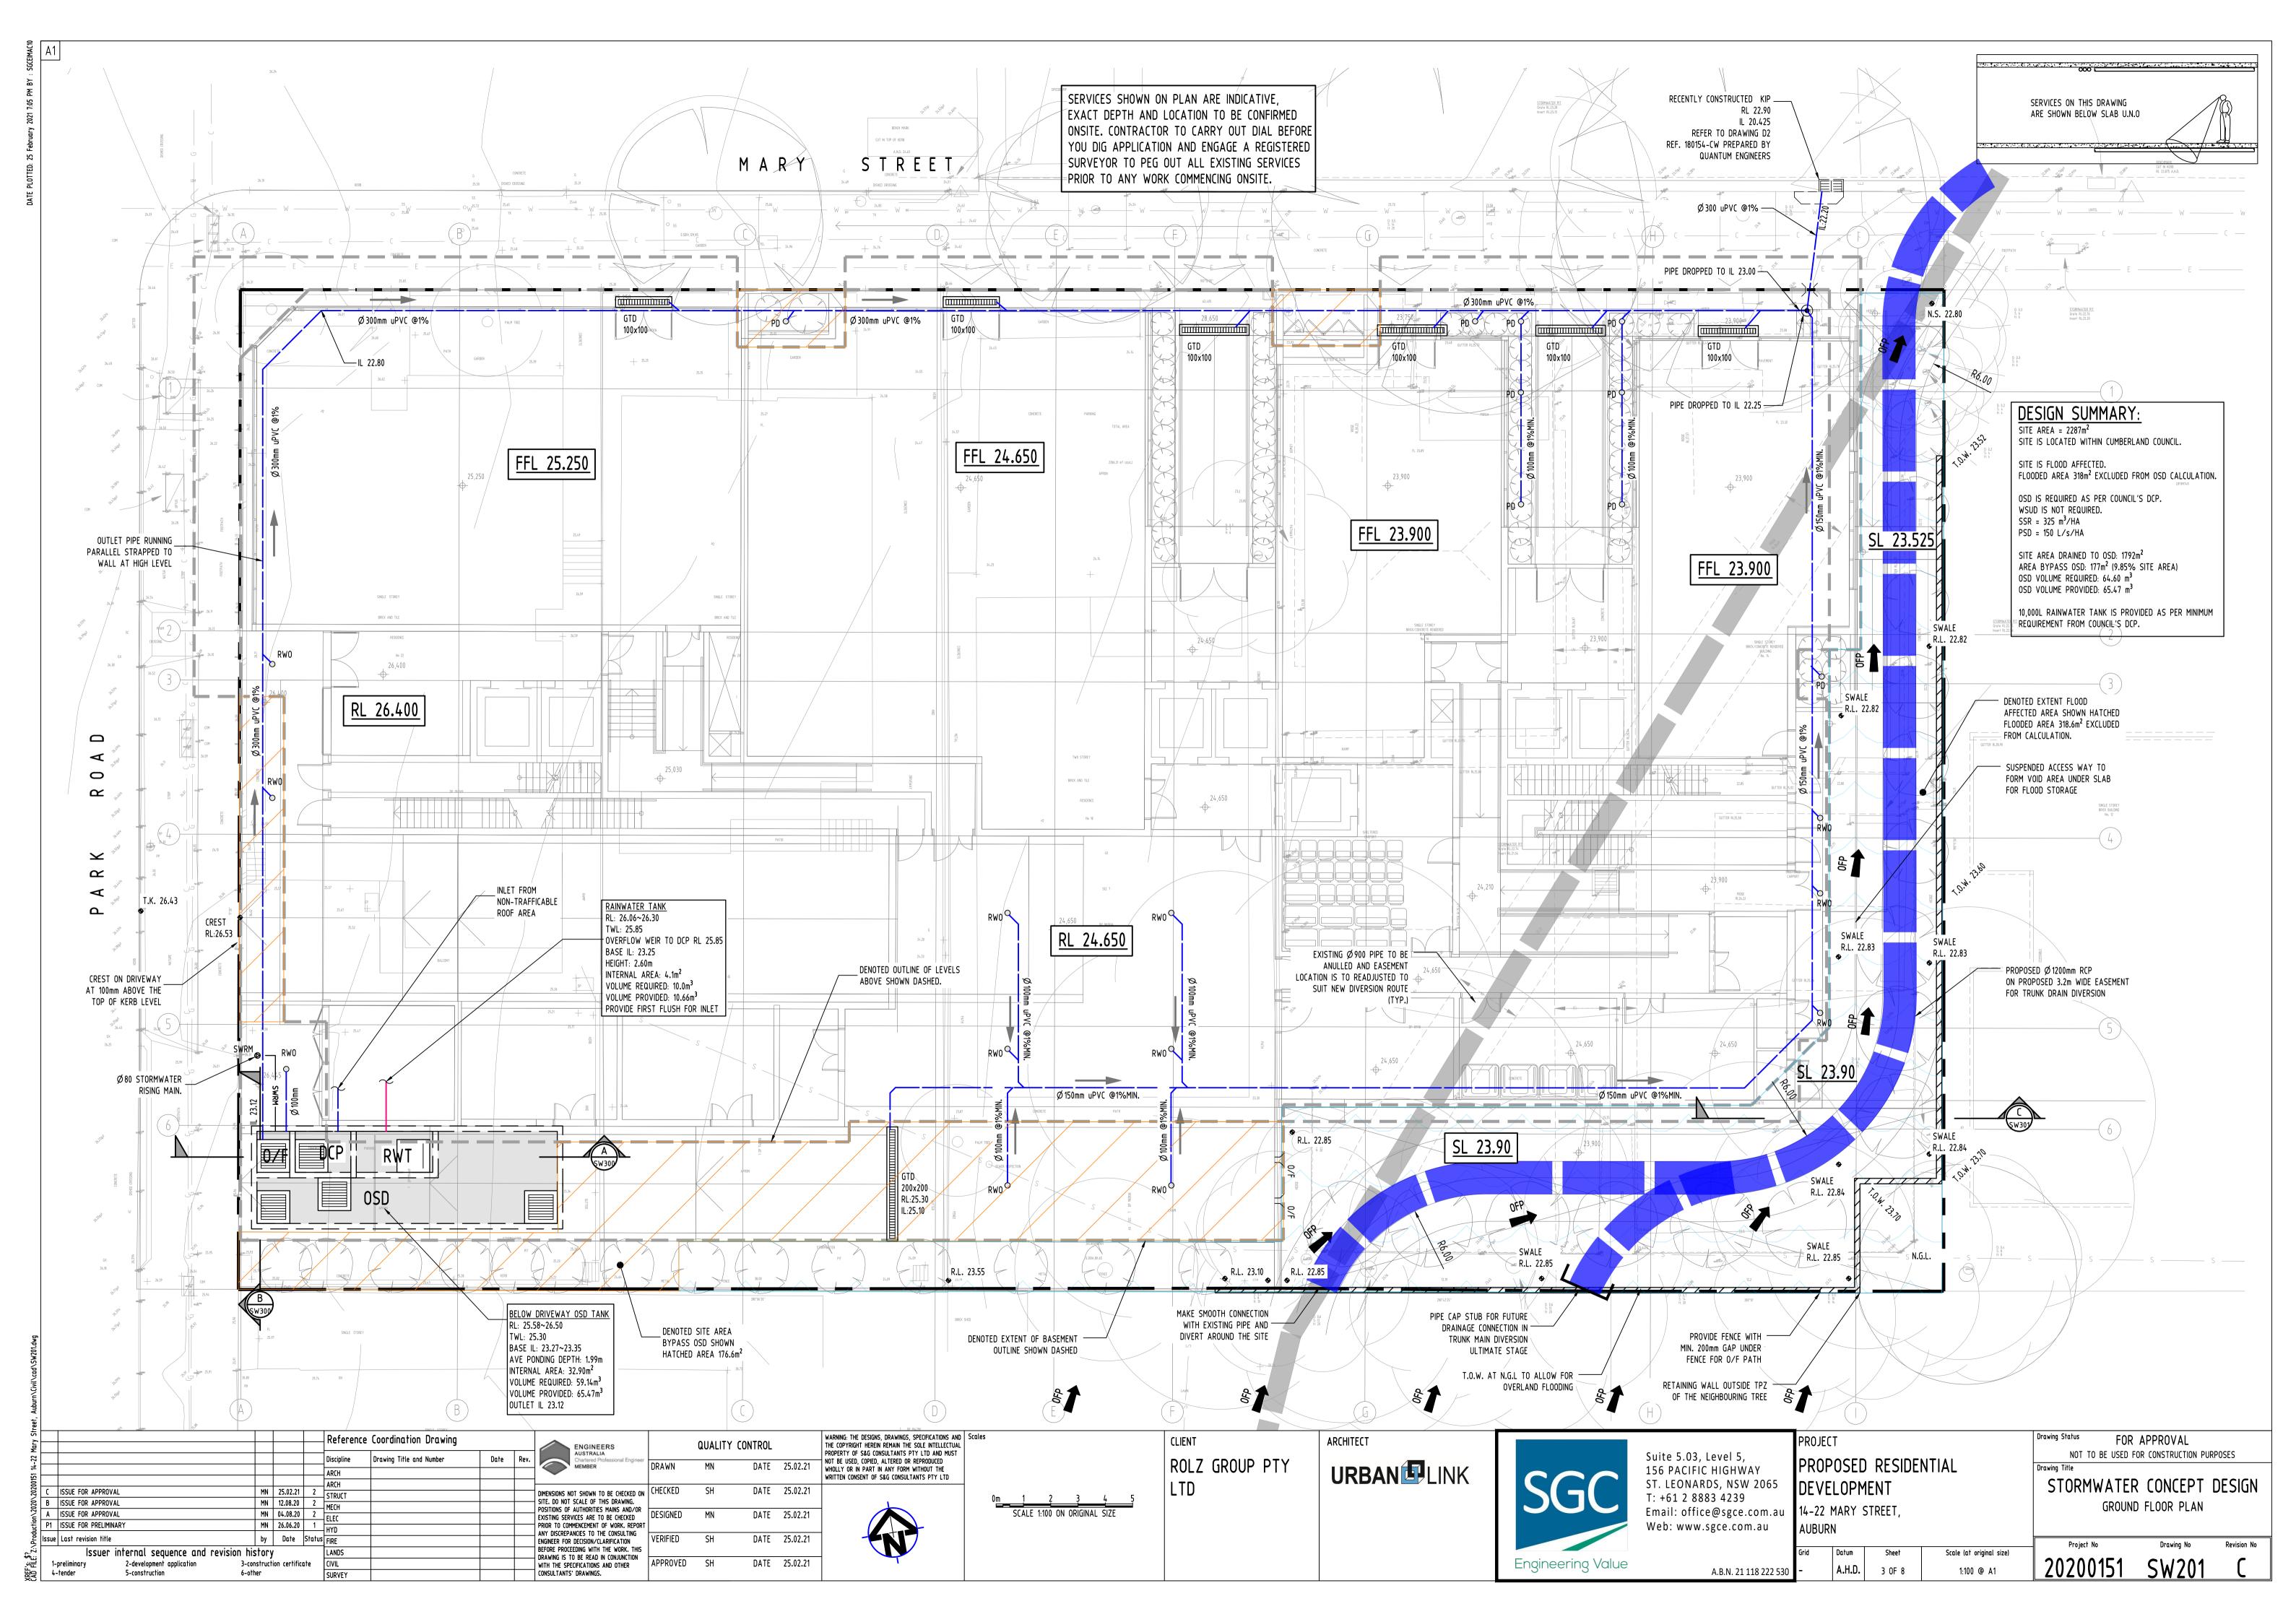
ARCHITECT:


**URBAN** LINK


CLIENT:


ROLZ GROUP PTY LTD



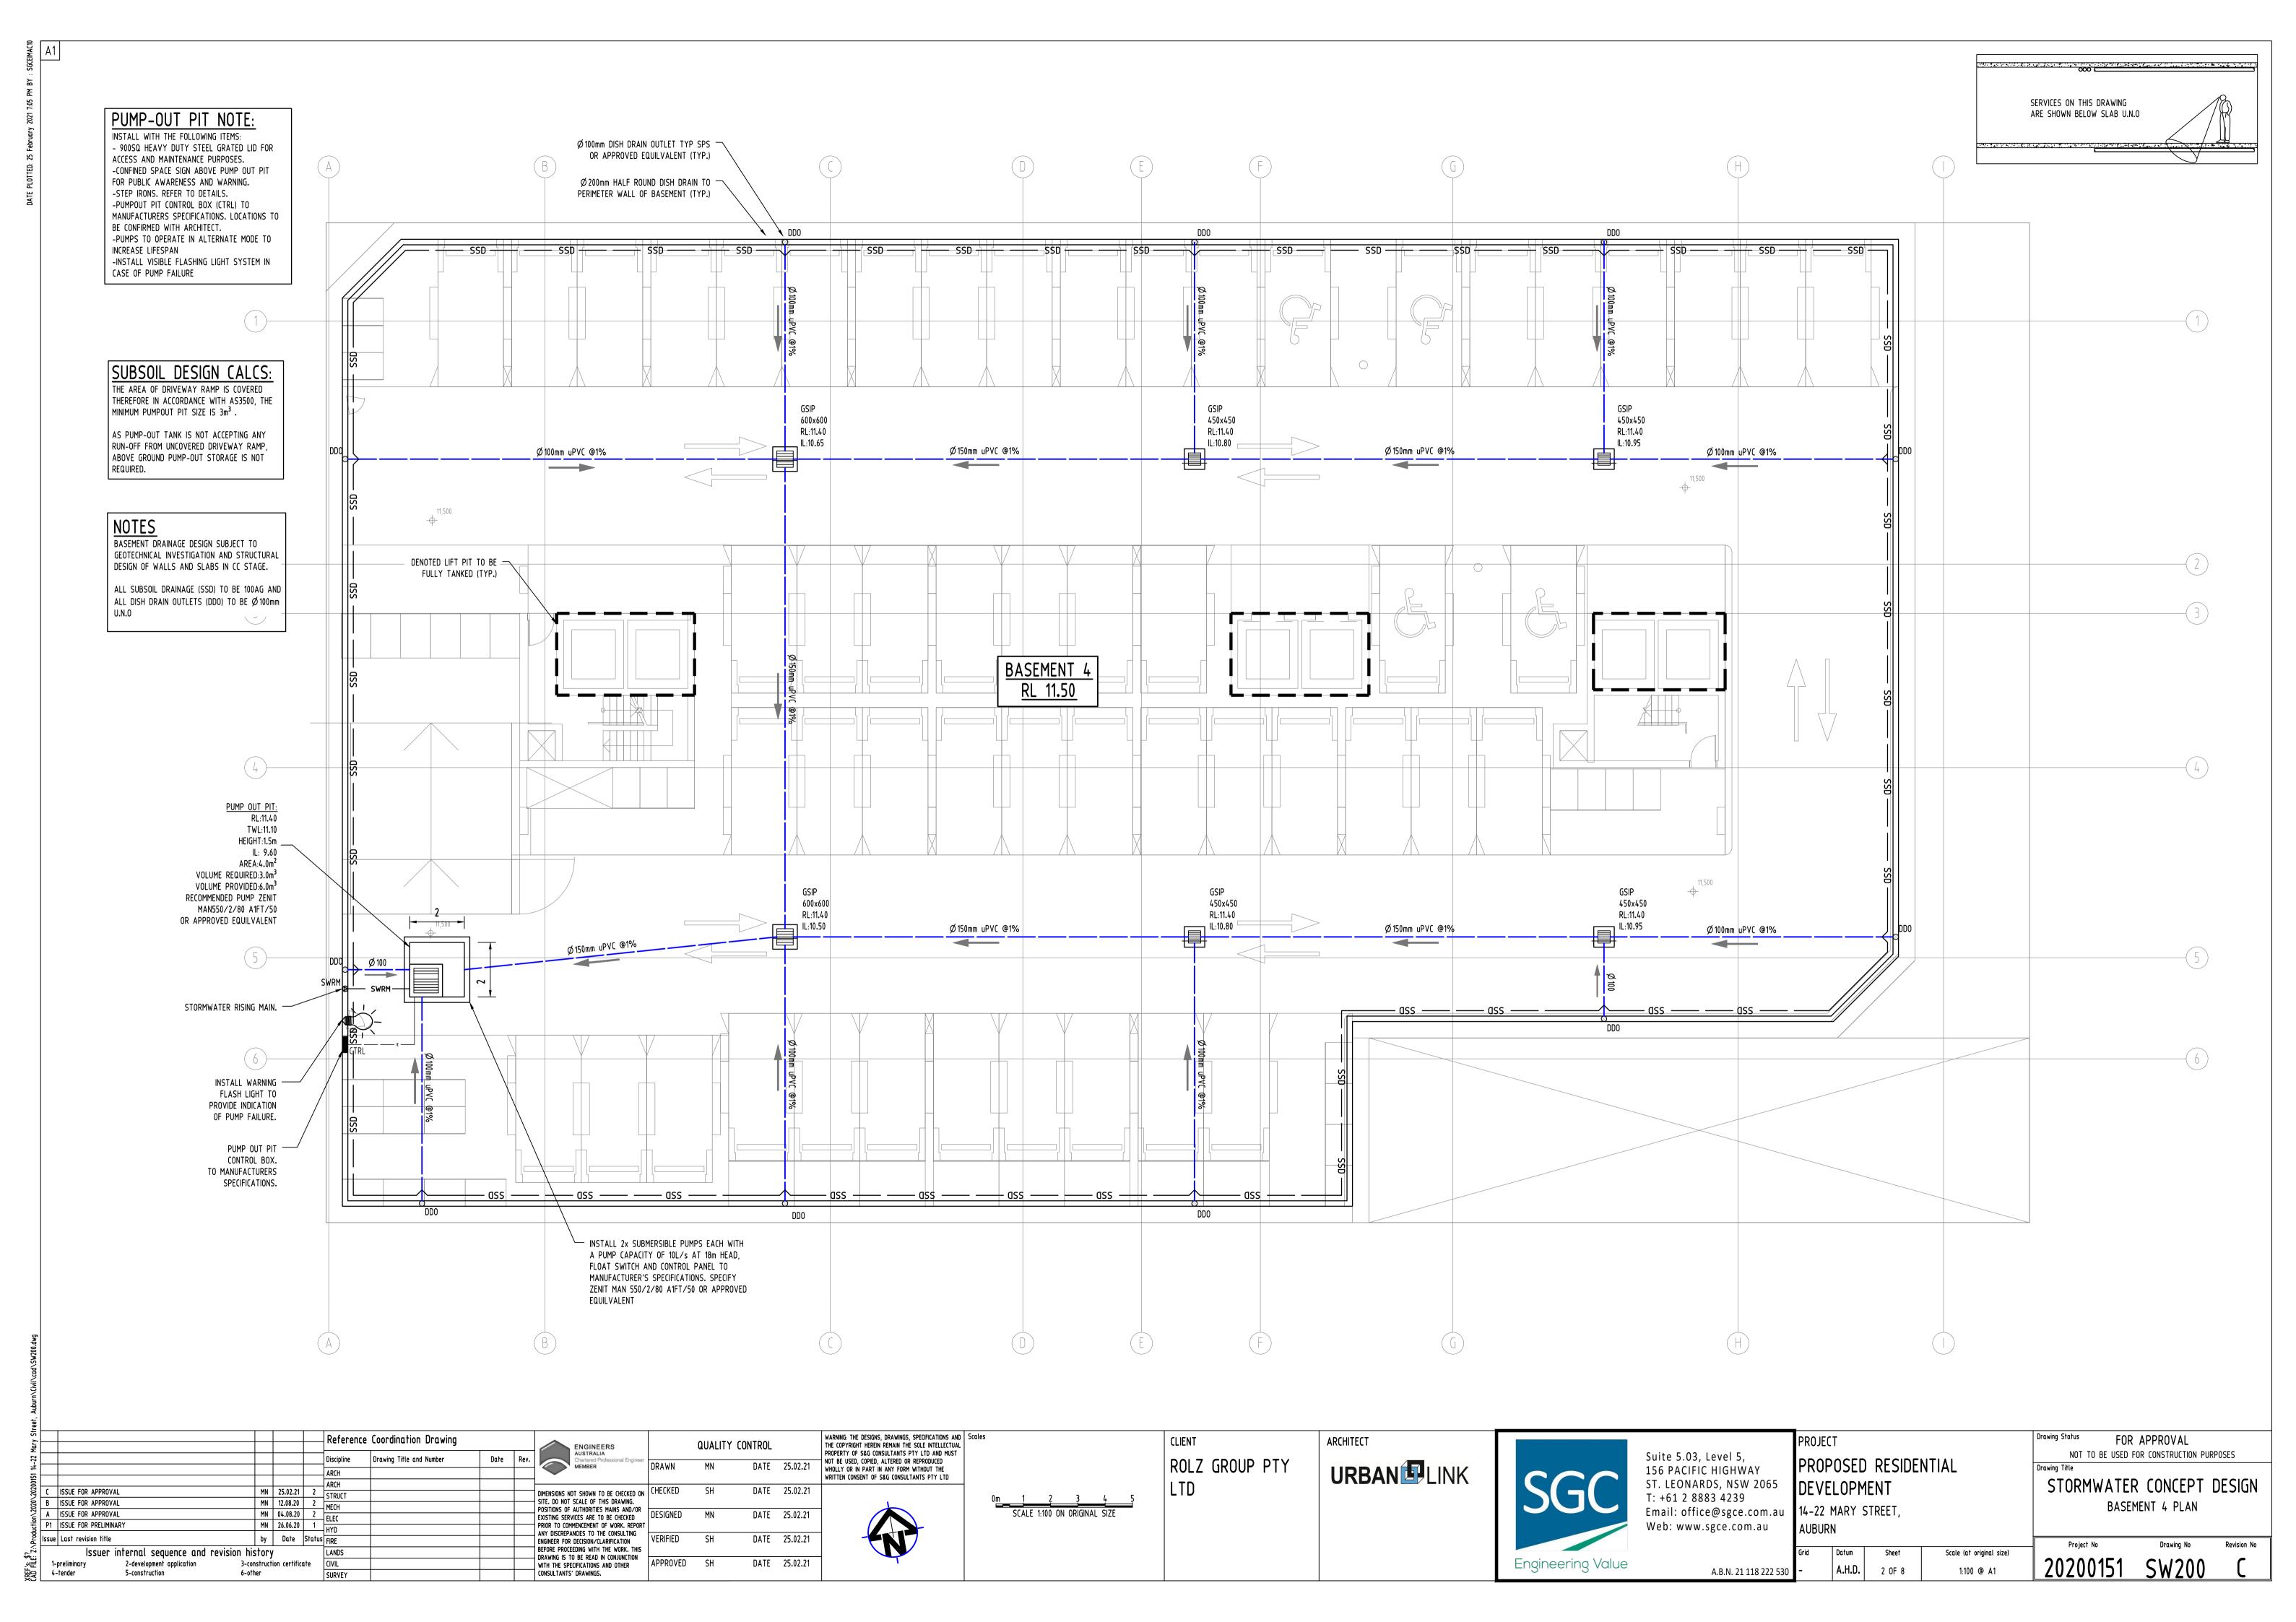


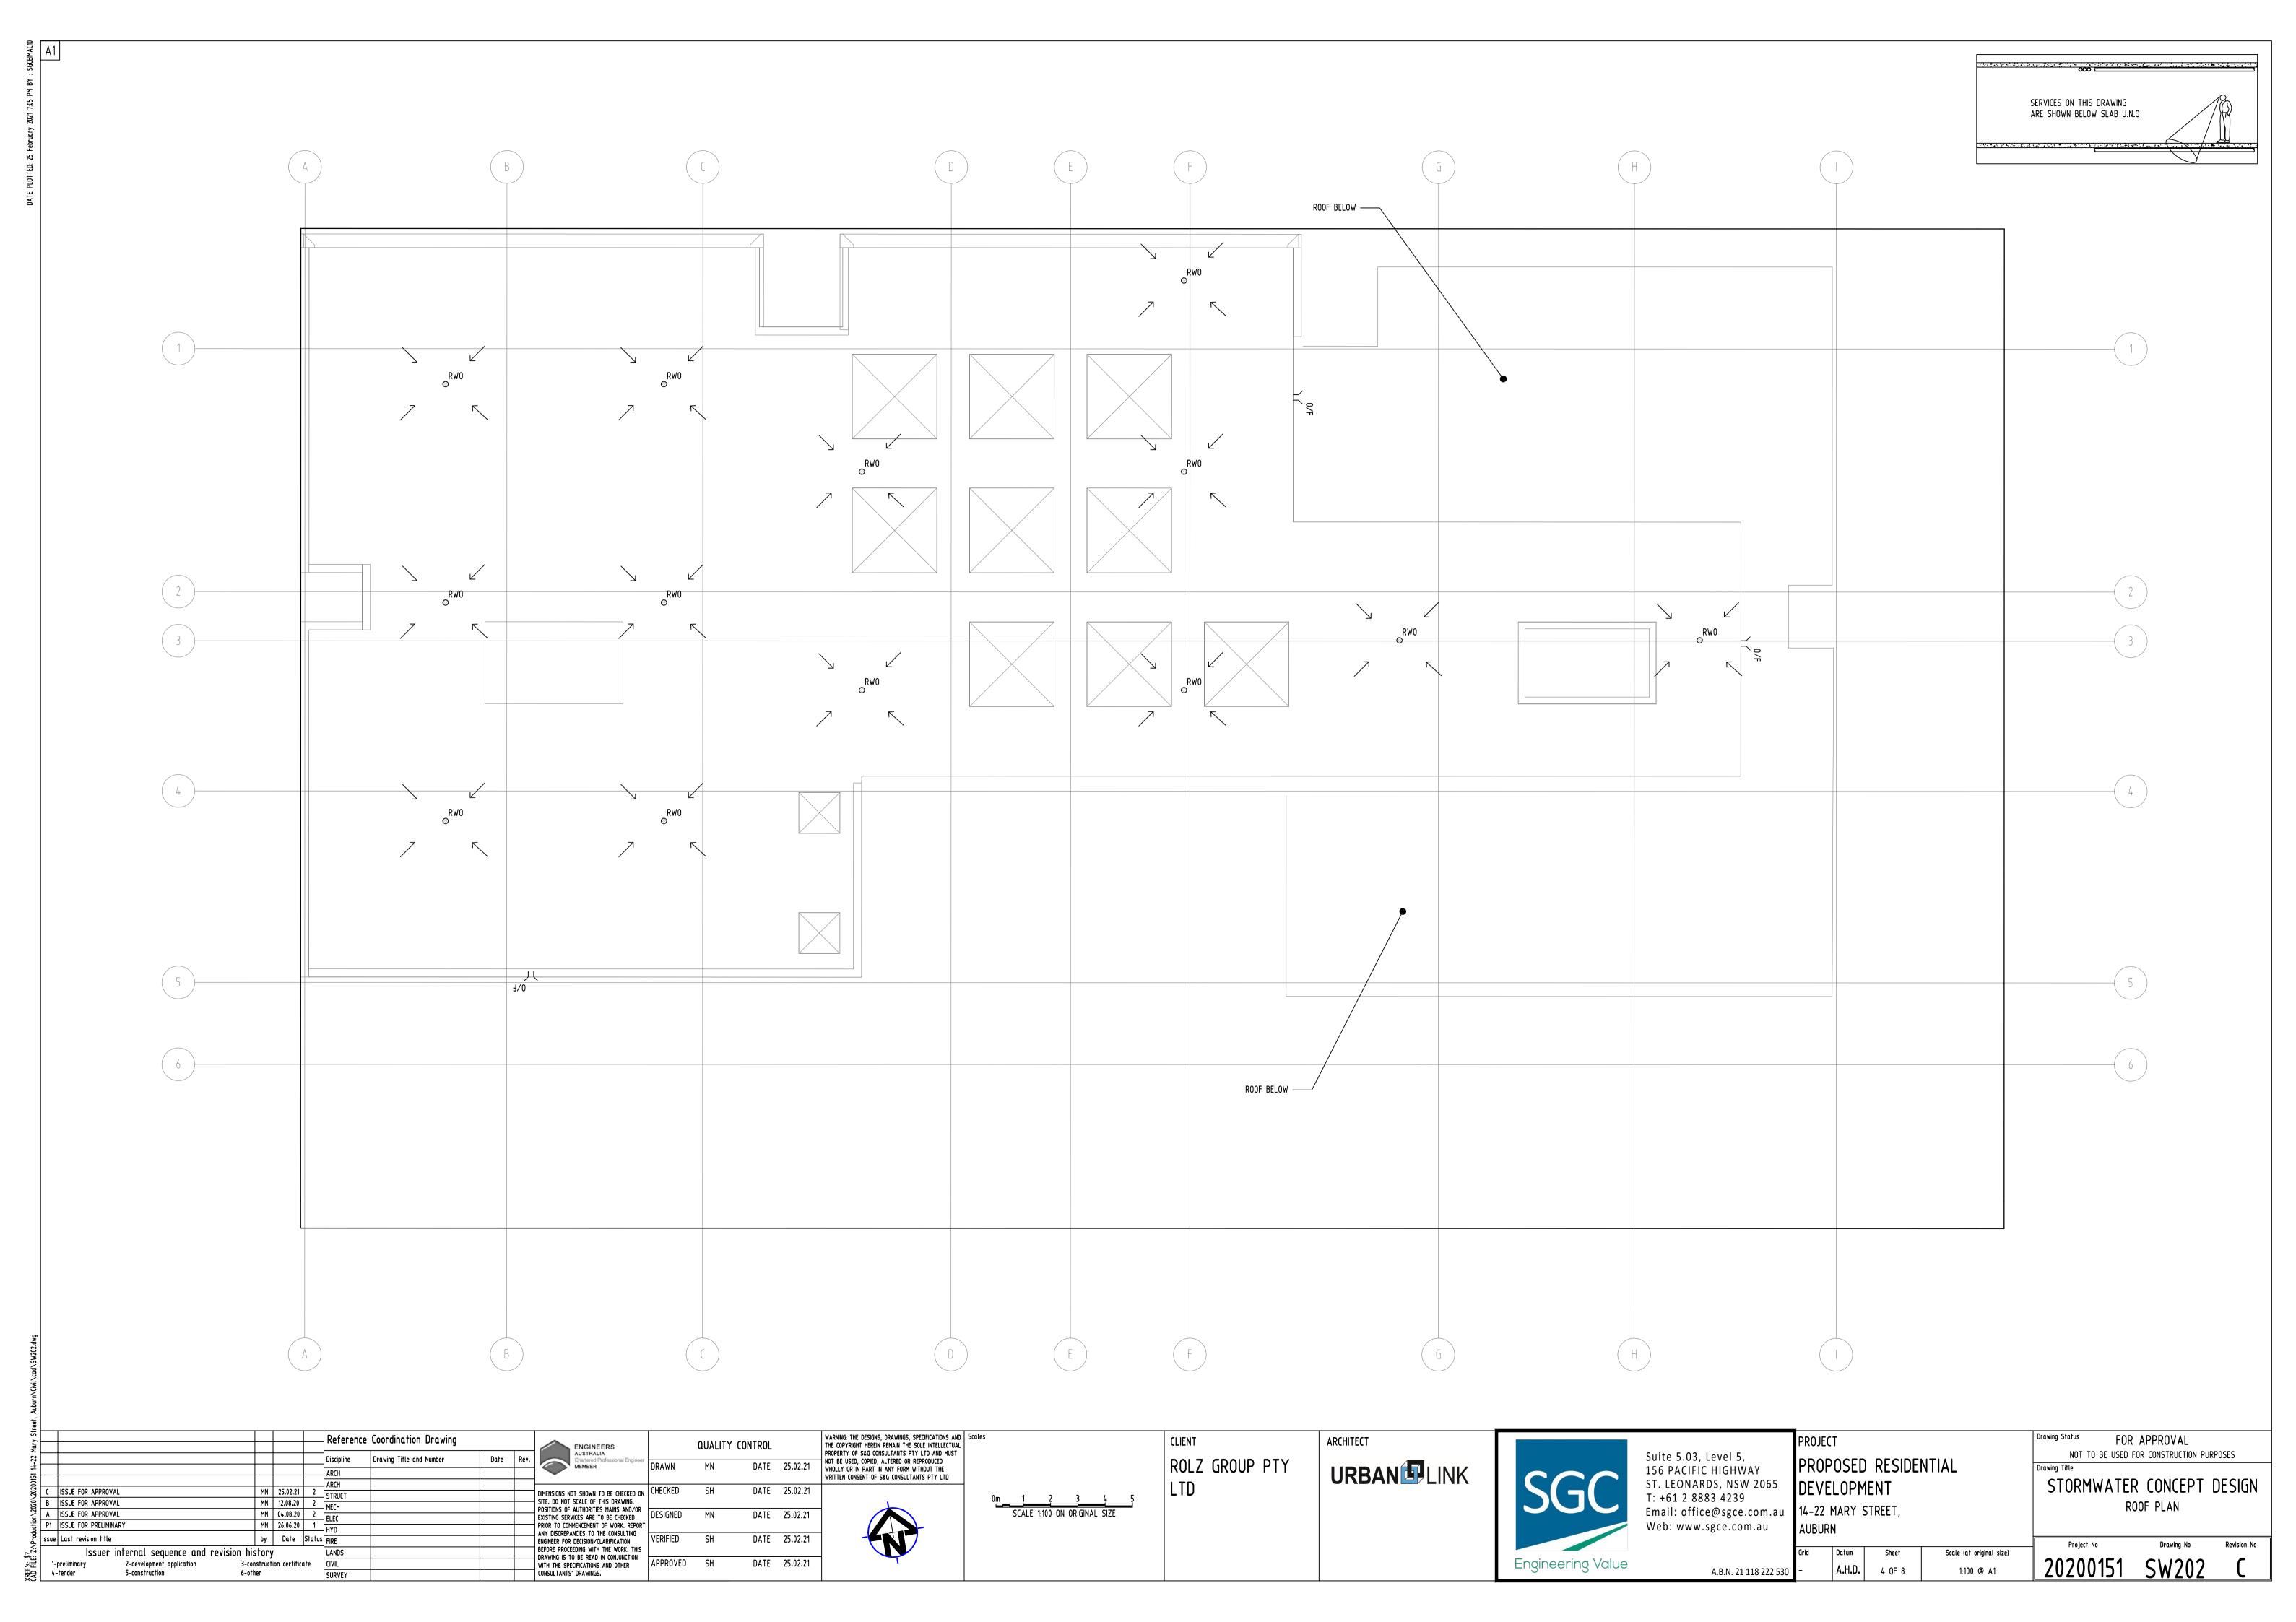


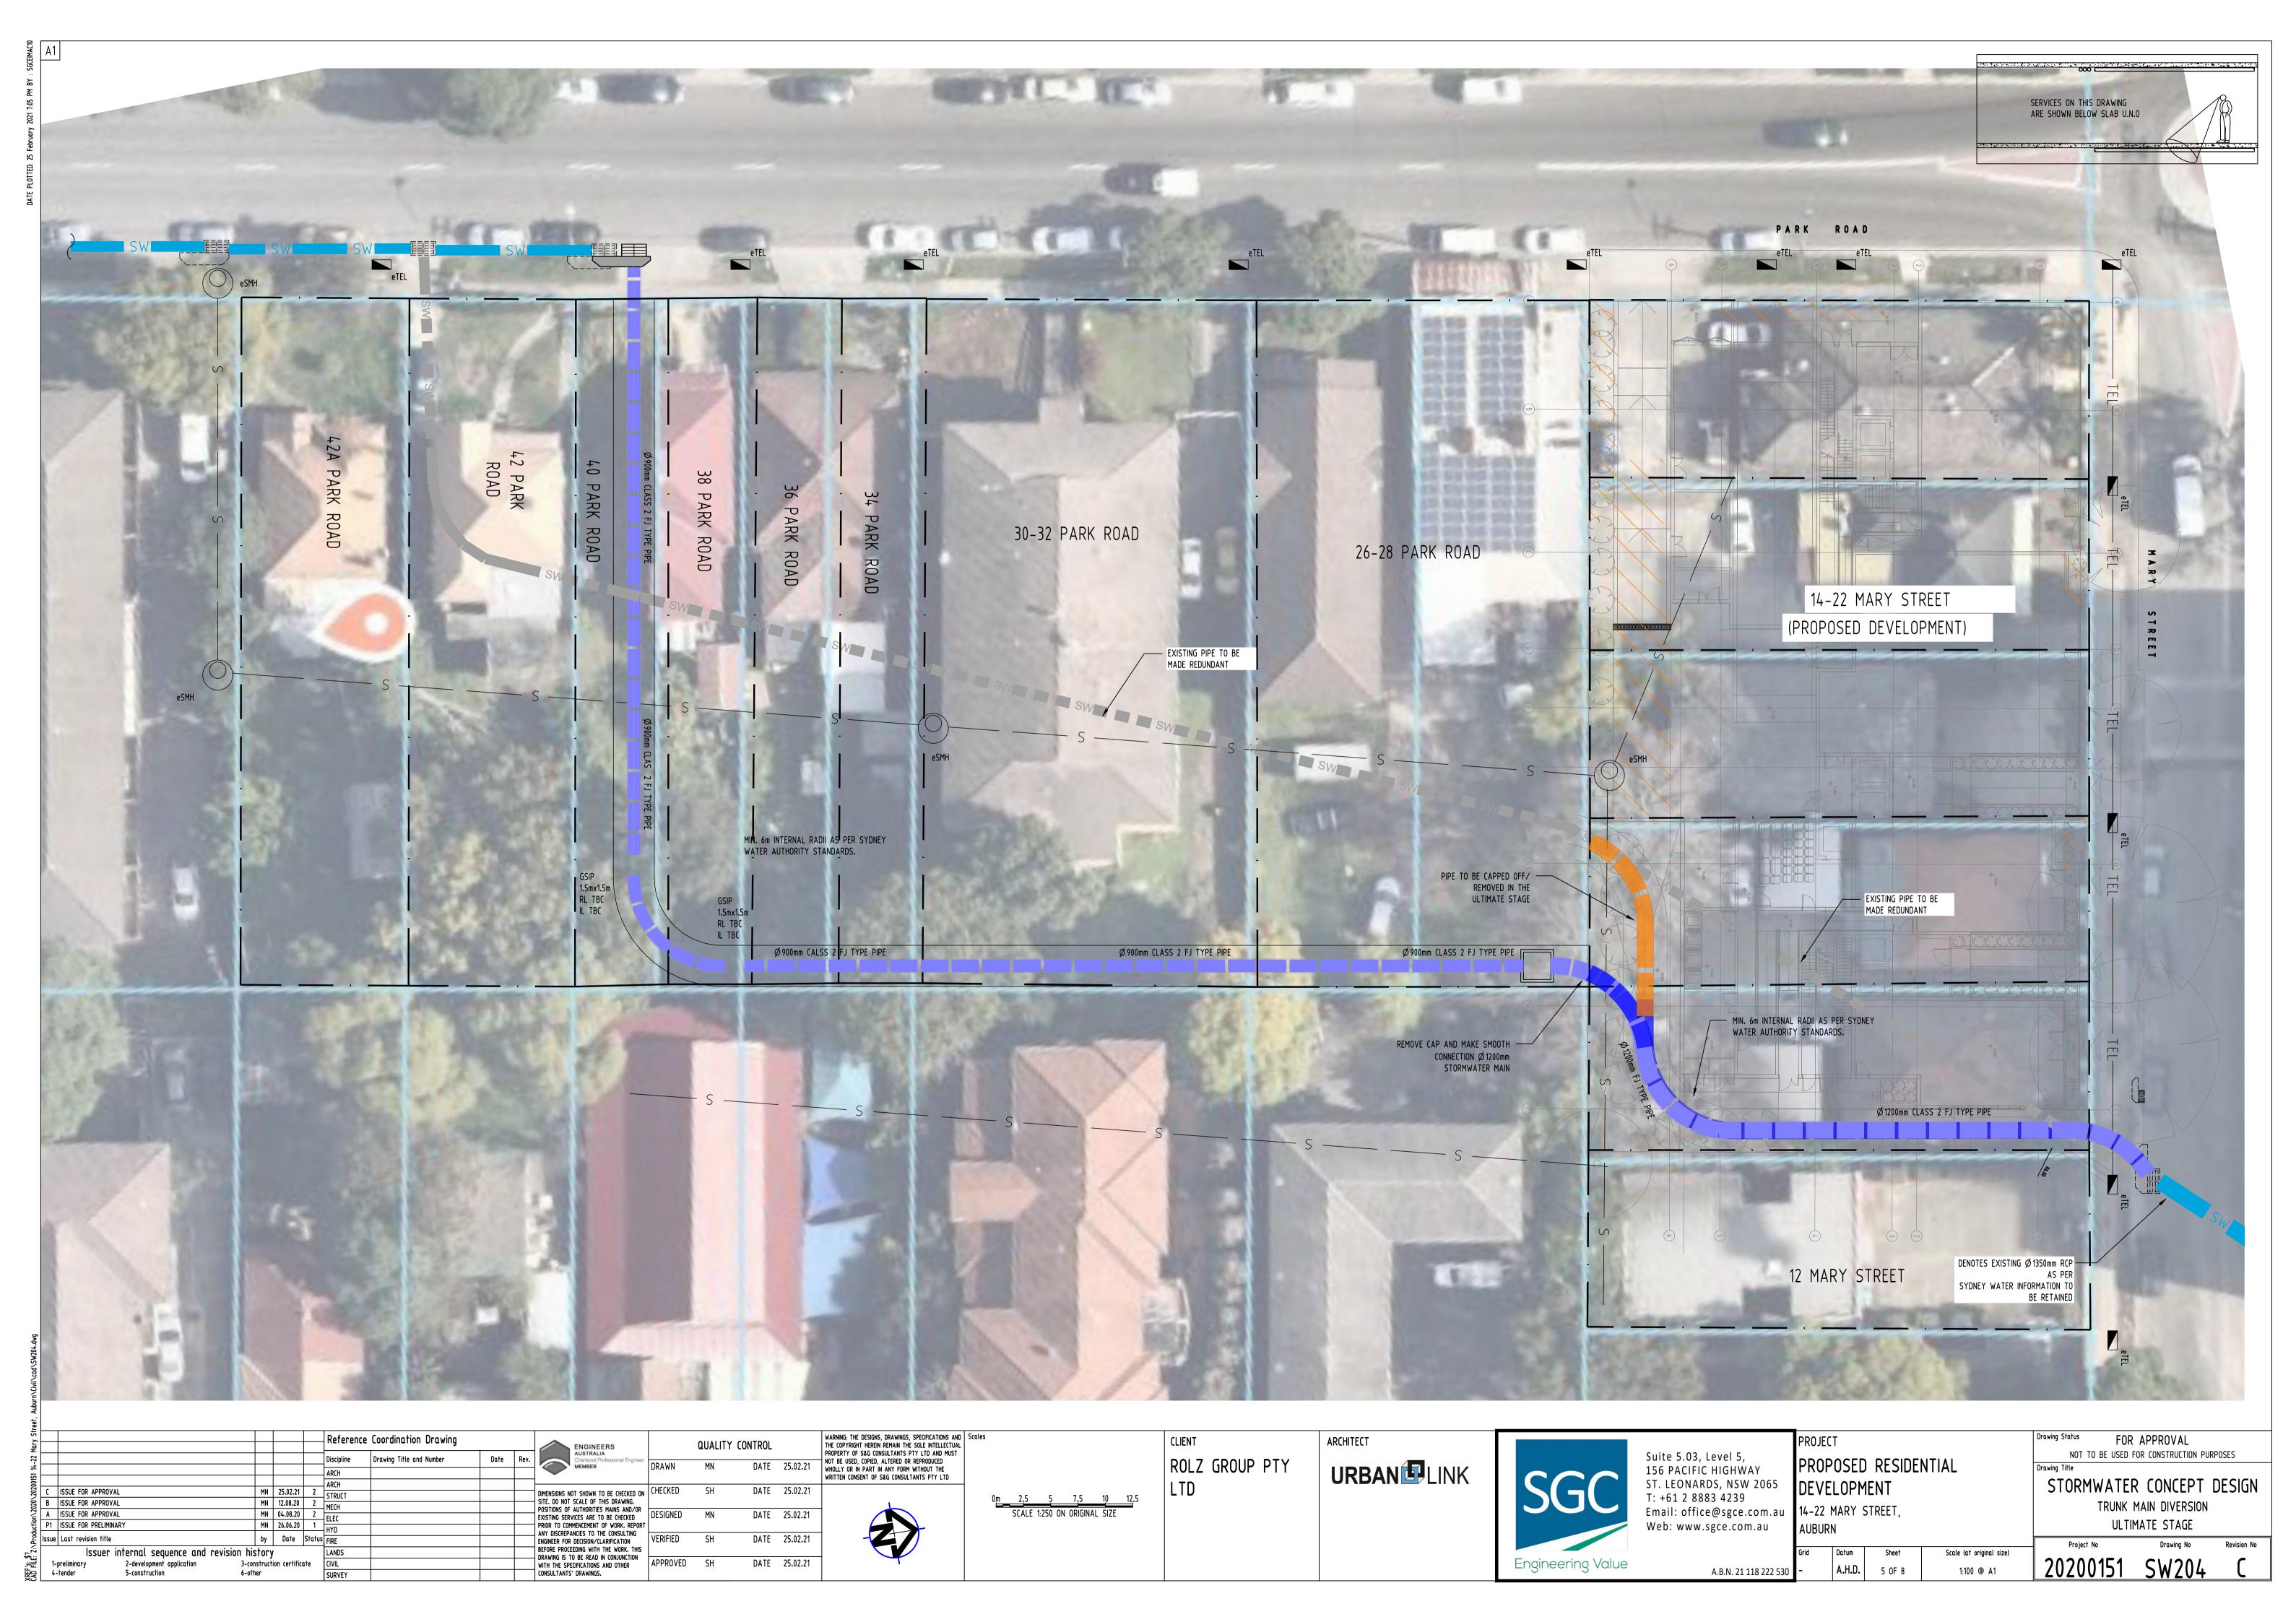

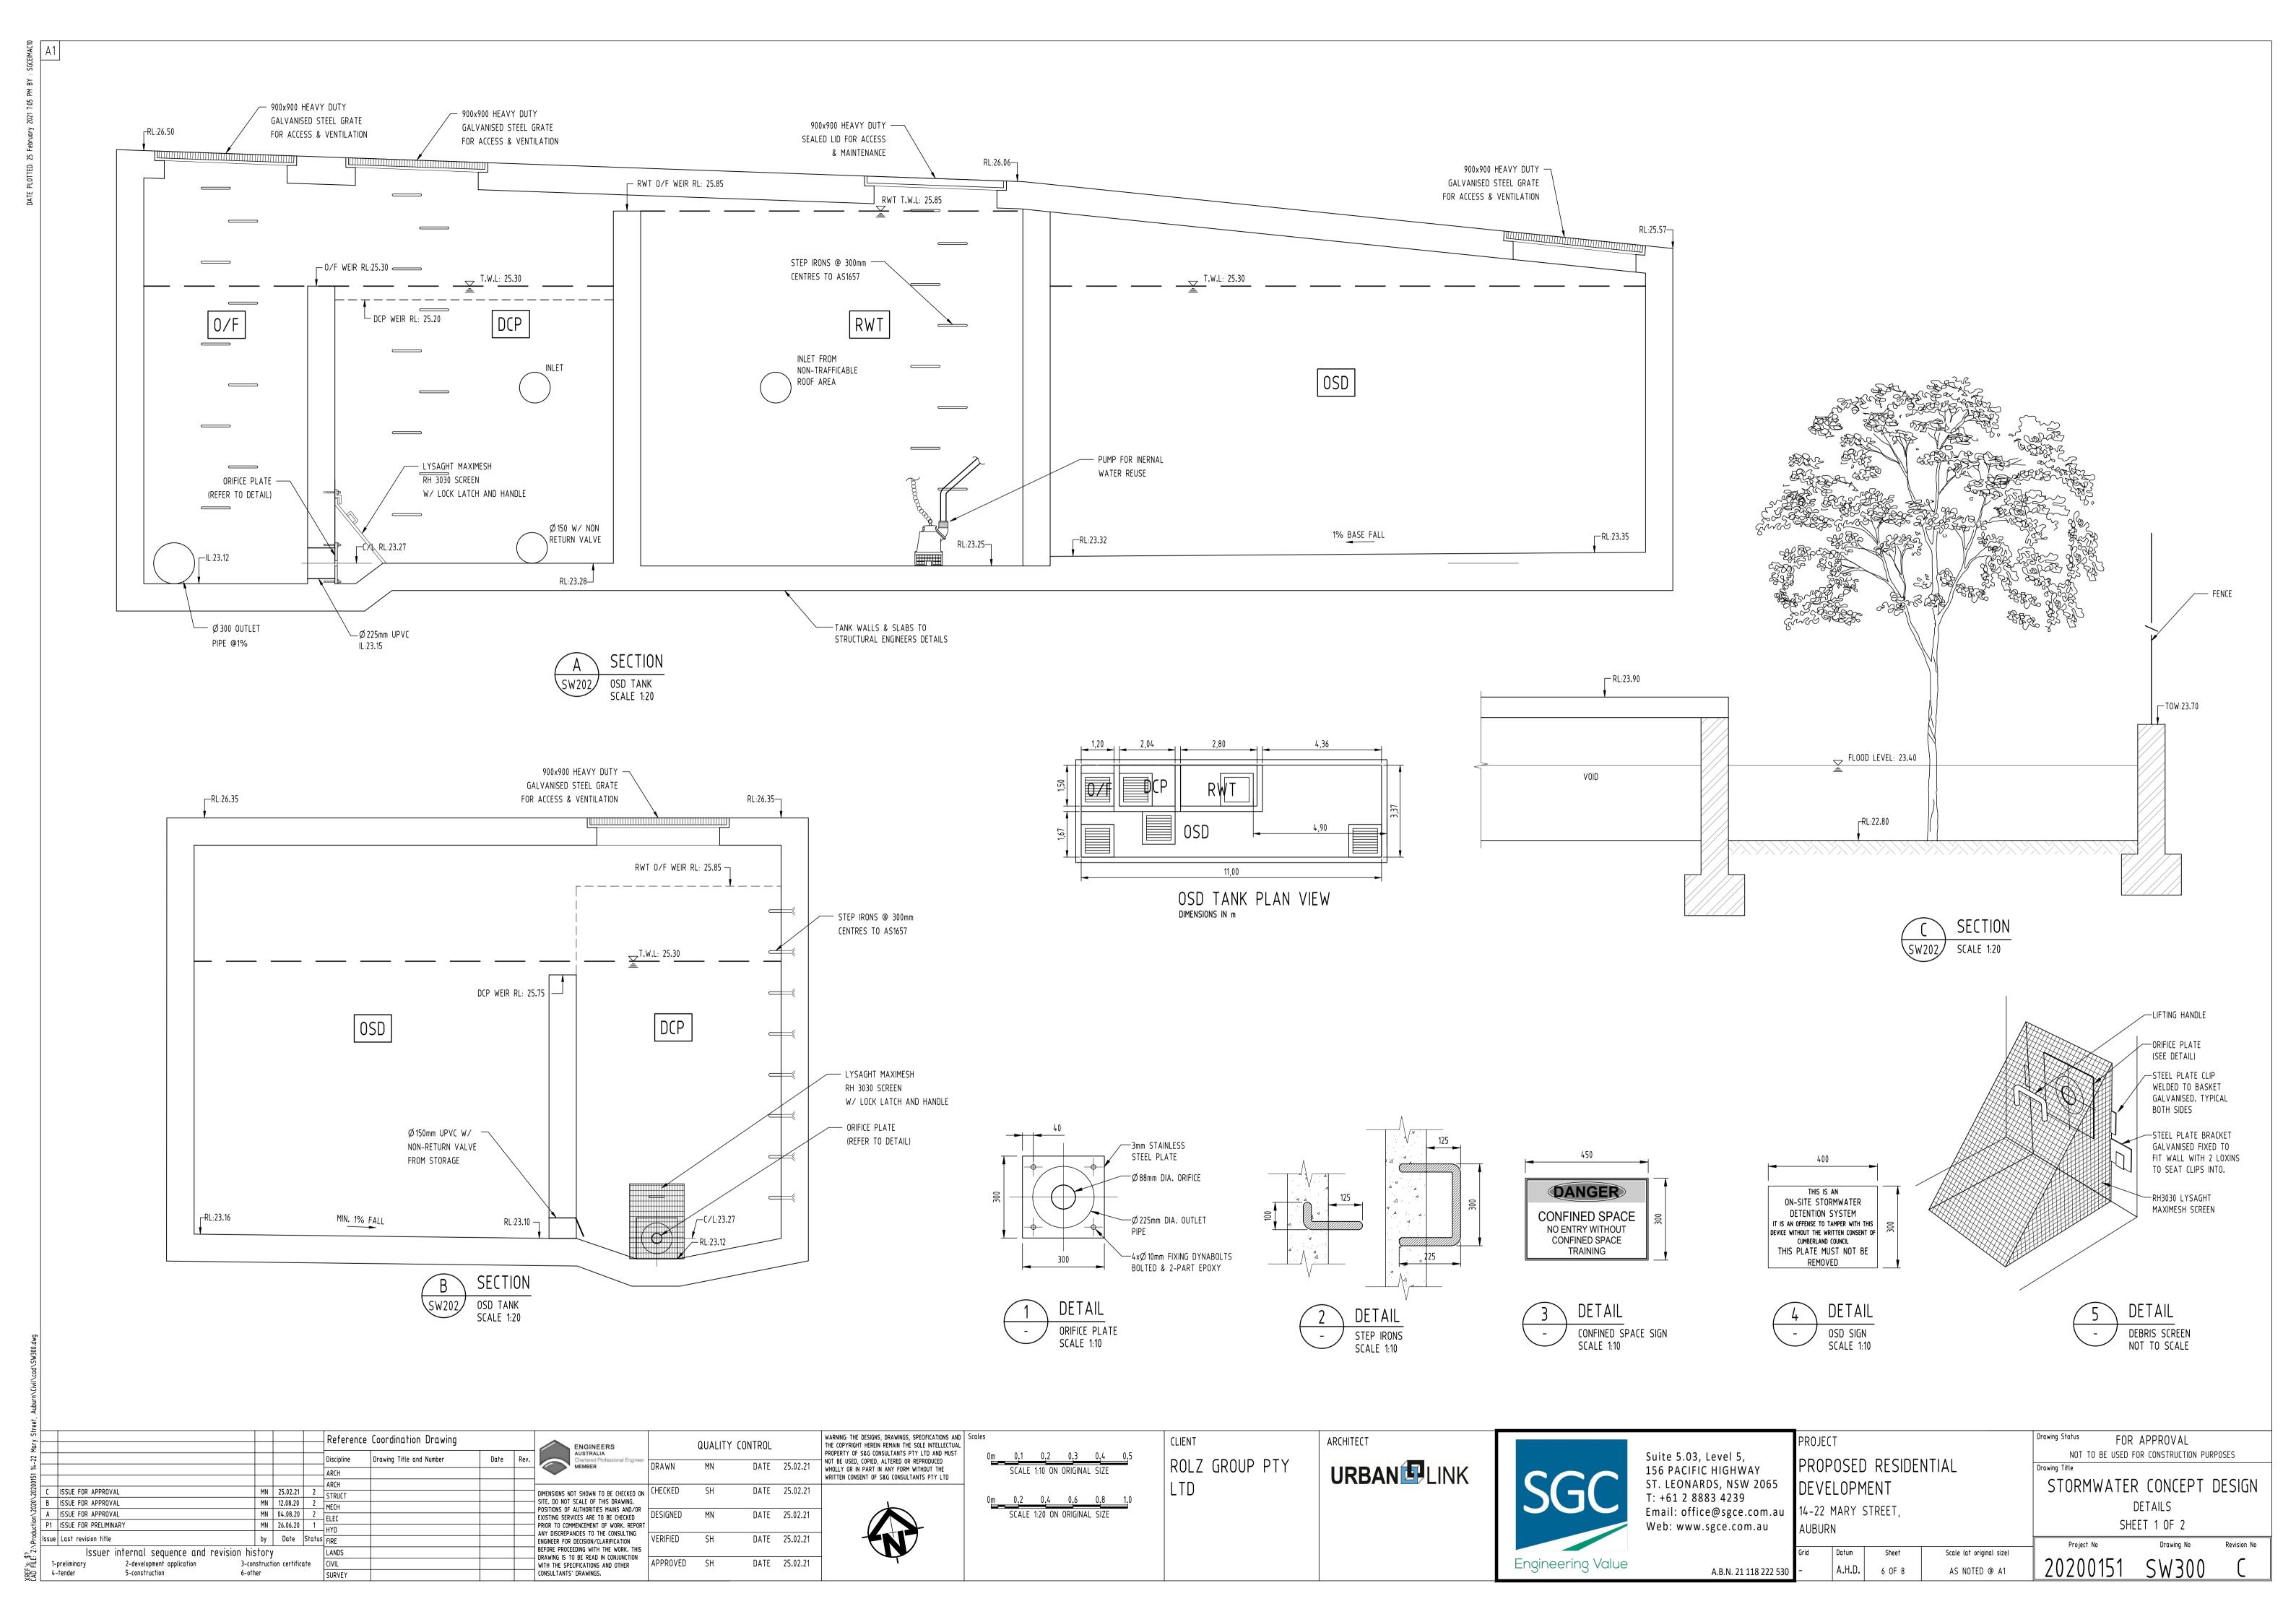





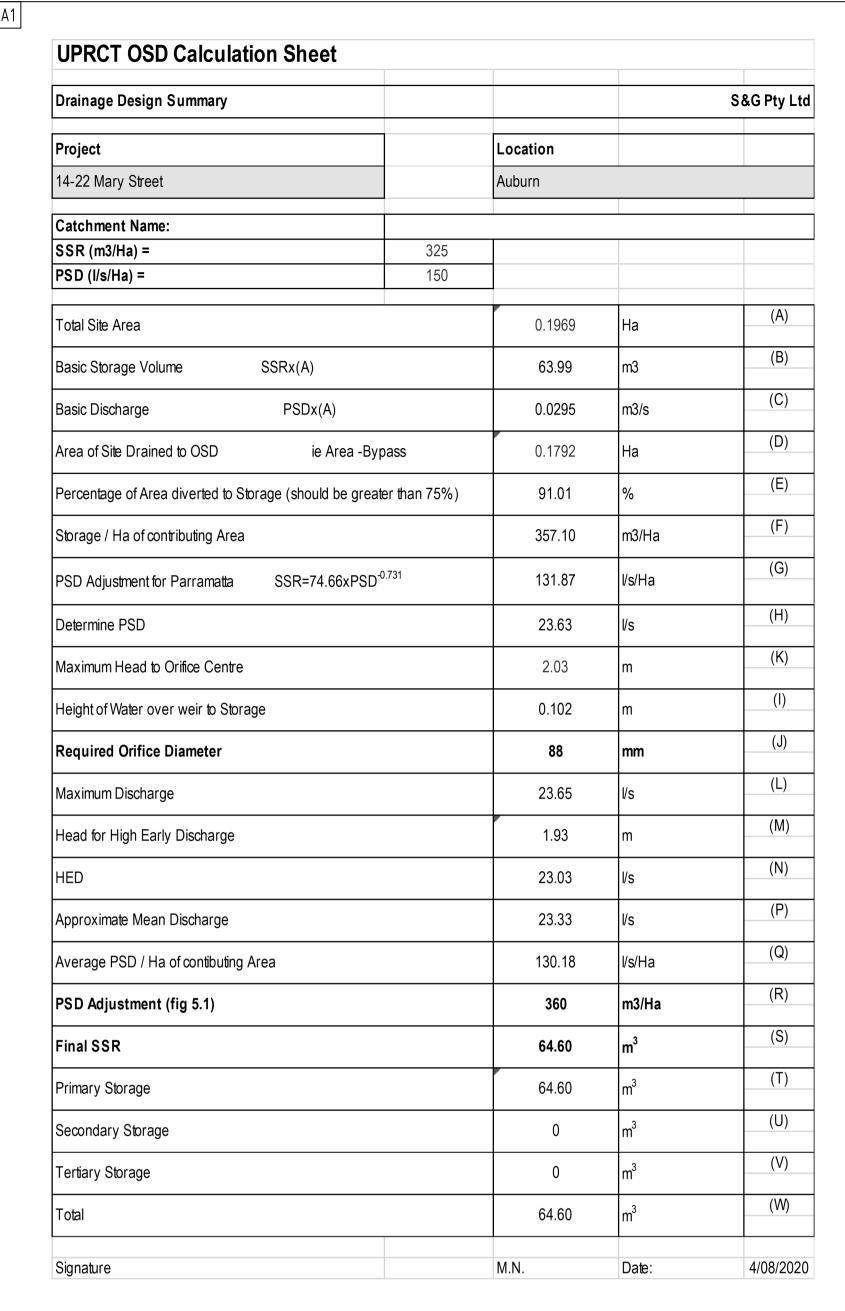


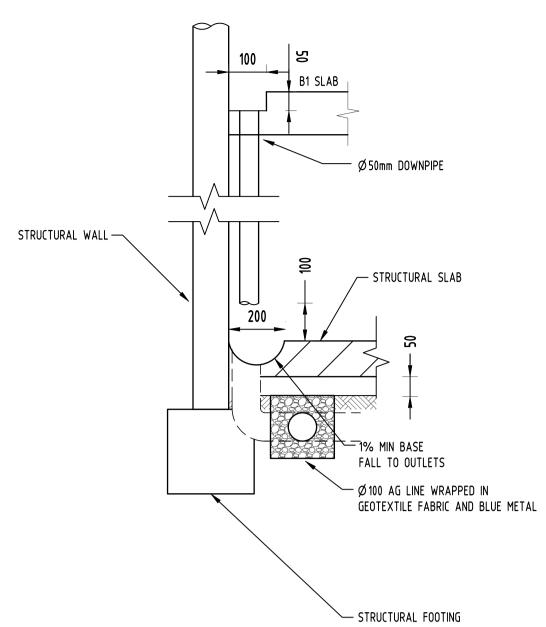




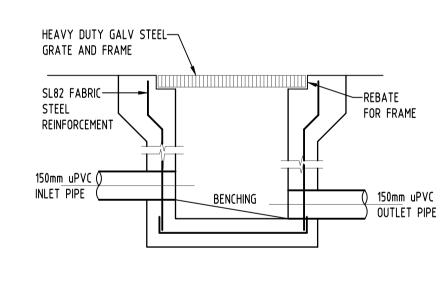

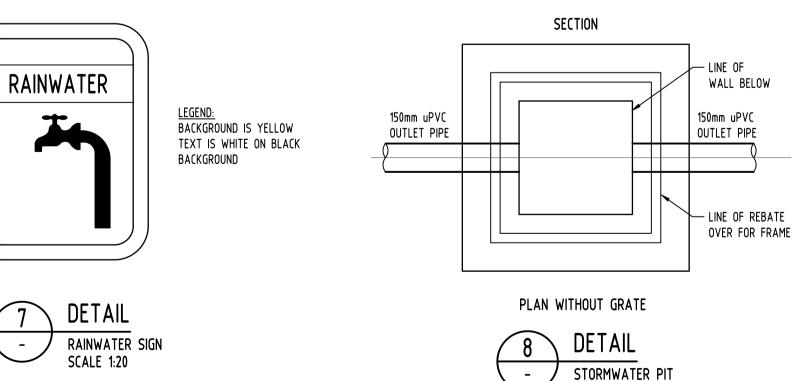


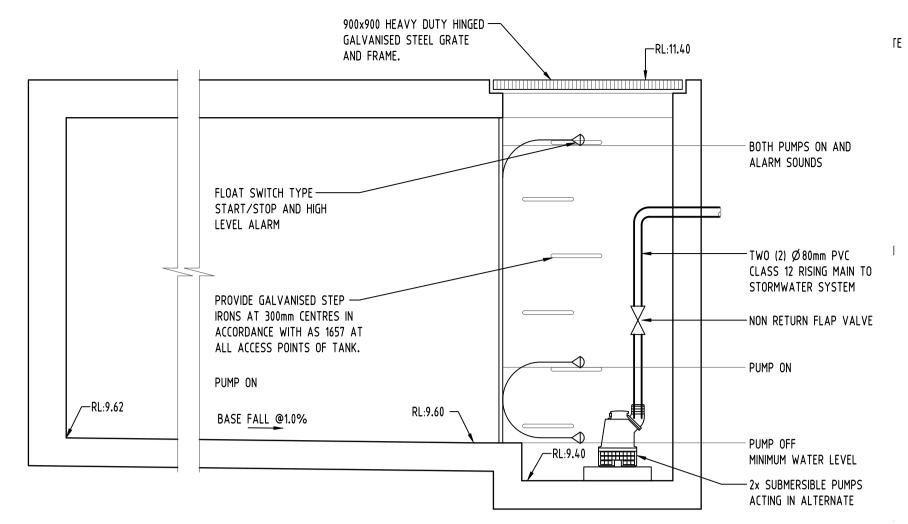



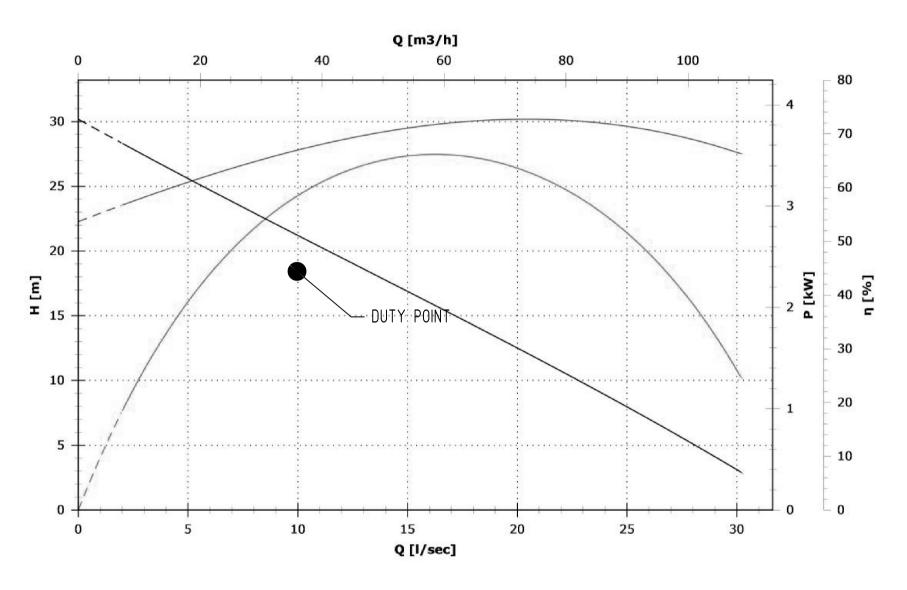

MAN 550/2/80 A1FT/50 PERFORMANCE CURVE

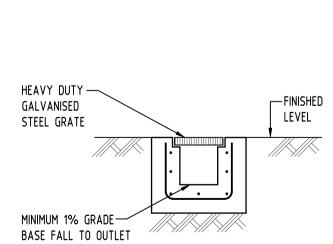

MEMBRANE — EXTENSION PIECE — AS REQUIRED TO SUIT SLAB THICKNESS		CONCRETE SL OUTLET TO STORMWAT 100mm DIAMETER DETAIL	AB
	( - )	RAINWATER OUTLET NOT TO SCALE	

ISSUE FOR APPROVAL B ISSUE FOR APPROVAL

A ISSUE FOR APPROVAL

P1 ISSUE FOR PRELIMINARY

Issuer internal sequence and revision history

2-development application

5-construction

Issue Last revision title

MN 25.02.21 2 STRUCT
MN 12.08.20 2 MECH
MN 04.08.20 2 ELEC


MN 26.06.20 1 HYD by Date Status FIRE

SURVEY

3-construction certificate

6-other

	ENGINEERS		QUALITY	CONTROL		W T P
۷.	Chartered Professional Engineer MEMBER	DRAWN	MN	DATE	25.02.21	N
	DIMENSIONS NOT SHOWN TO BE CHECKED ON SITE. DO NOT SCALE OF THIS DRAWING.	CHECKED	SH	DATE	25.02.21	
	POSITIONS OF AUTHORITIES MAINS AND/OR EXISTING SERVICES ARE TO BE CHECKED PRIOR TO COMMENCEMENT OF WORK. REPORT	DESIGNED	MN	DATE	25.02.21	
	ANY DISCREPANCIES TO THE CONSULTING ENGINEER FOR DECISION/CLARIFICATION BEFORE PROCEEDING WITH THE WORK. THIS DRAWING IS TO BE DEAD IN COMMINICATION	VERIFIED	SH	DATE	25.02.21	
	DRAWING IS TO BE READ IN CONJUNCTION WITH THE SPECIFICATIONS AND OTHER CONSULTANTS' DRAWINGS.	APPROVED	SH	DATE	25.02.21	

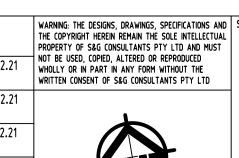

ND AL	Scales						
<u>ר</u>	0 <u>m</u>	0,1	0,2	0,3	0,4	<u>0</u> .5	
		SCALE	1:10 ON	ORIGINAL	SIZE		
	0 <u>m</u>	0,2	0,4	0,6	0,8	<u>1.</u> 0	
		SCALE	1:20 ON	N ORIGINA	AL SIZE		

INT	ARCHITECT
DLZ GROUP PTY	URBAN



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PROPOSED RESIDEN		PROJECT
, NSW 2065 DEVELOPMENT	IGHWAY	PROPOSED RESIDENTI
4239 Osgce.com.au te.com.au AUBURN	4239 Sgce.com.au	14-22 MARY STREET,

Drawing Status FOR APPROVAL
NOT TO BE USED FOR CONSTRUCTION PURPOSES
Drawing Title
STORMWATER CONCEPT DESIG

DETAILS SHEET 2 OF 2

A.H.D. A.B.N. 21 118 222 530

Scale (at original size) 7 OF 8 AS NOTED @ A1

LEGEND:

STORMWATER LINE

RW STORMWATER LINE TO RAINWATER TANK

——— SSD ——— SUBSOIL LINE

---- SWRM----- STORMWATER RISING MAIN

————— e———— EXISTING STORMWATER LINE

— W — AUTHORITY WATER LINE

— G — G — AUTHORITY GAS LINE

—— E —— AUTHORITY ELECTRICITY LINE

—— FO—— FO—— FO—— AUTHORITY FIBRE OPTIC LINE

TEL————— AUTHORITY COMMS LINE

GRATED SURFACE INLET PIT

GRATED SURFACE INLET PIT

WITH ENVIROPOD INSERT

EXISTING KERB INLET PIT

OVERLAND FLOW PATH

RAINWATER OUTLET

DISH DRAIN OUTLET

PLANTER DRAIN

DOWNPIPE


Reference Coordination Drawing

Drawing Title and Number

TOPPING SLAB OR TILE FINISH

STORMWATER PIT SCALE N.T.S.

GRATED TRENCH DRAIN SCALE N.T.S.

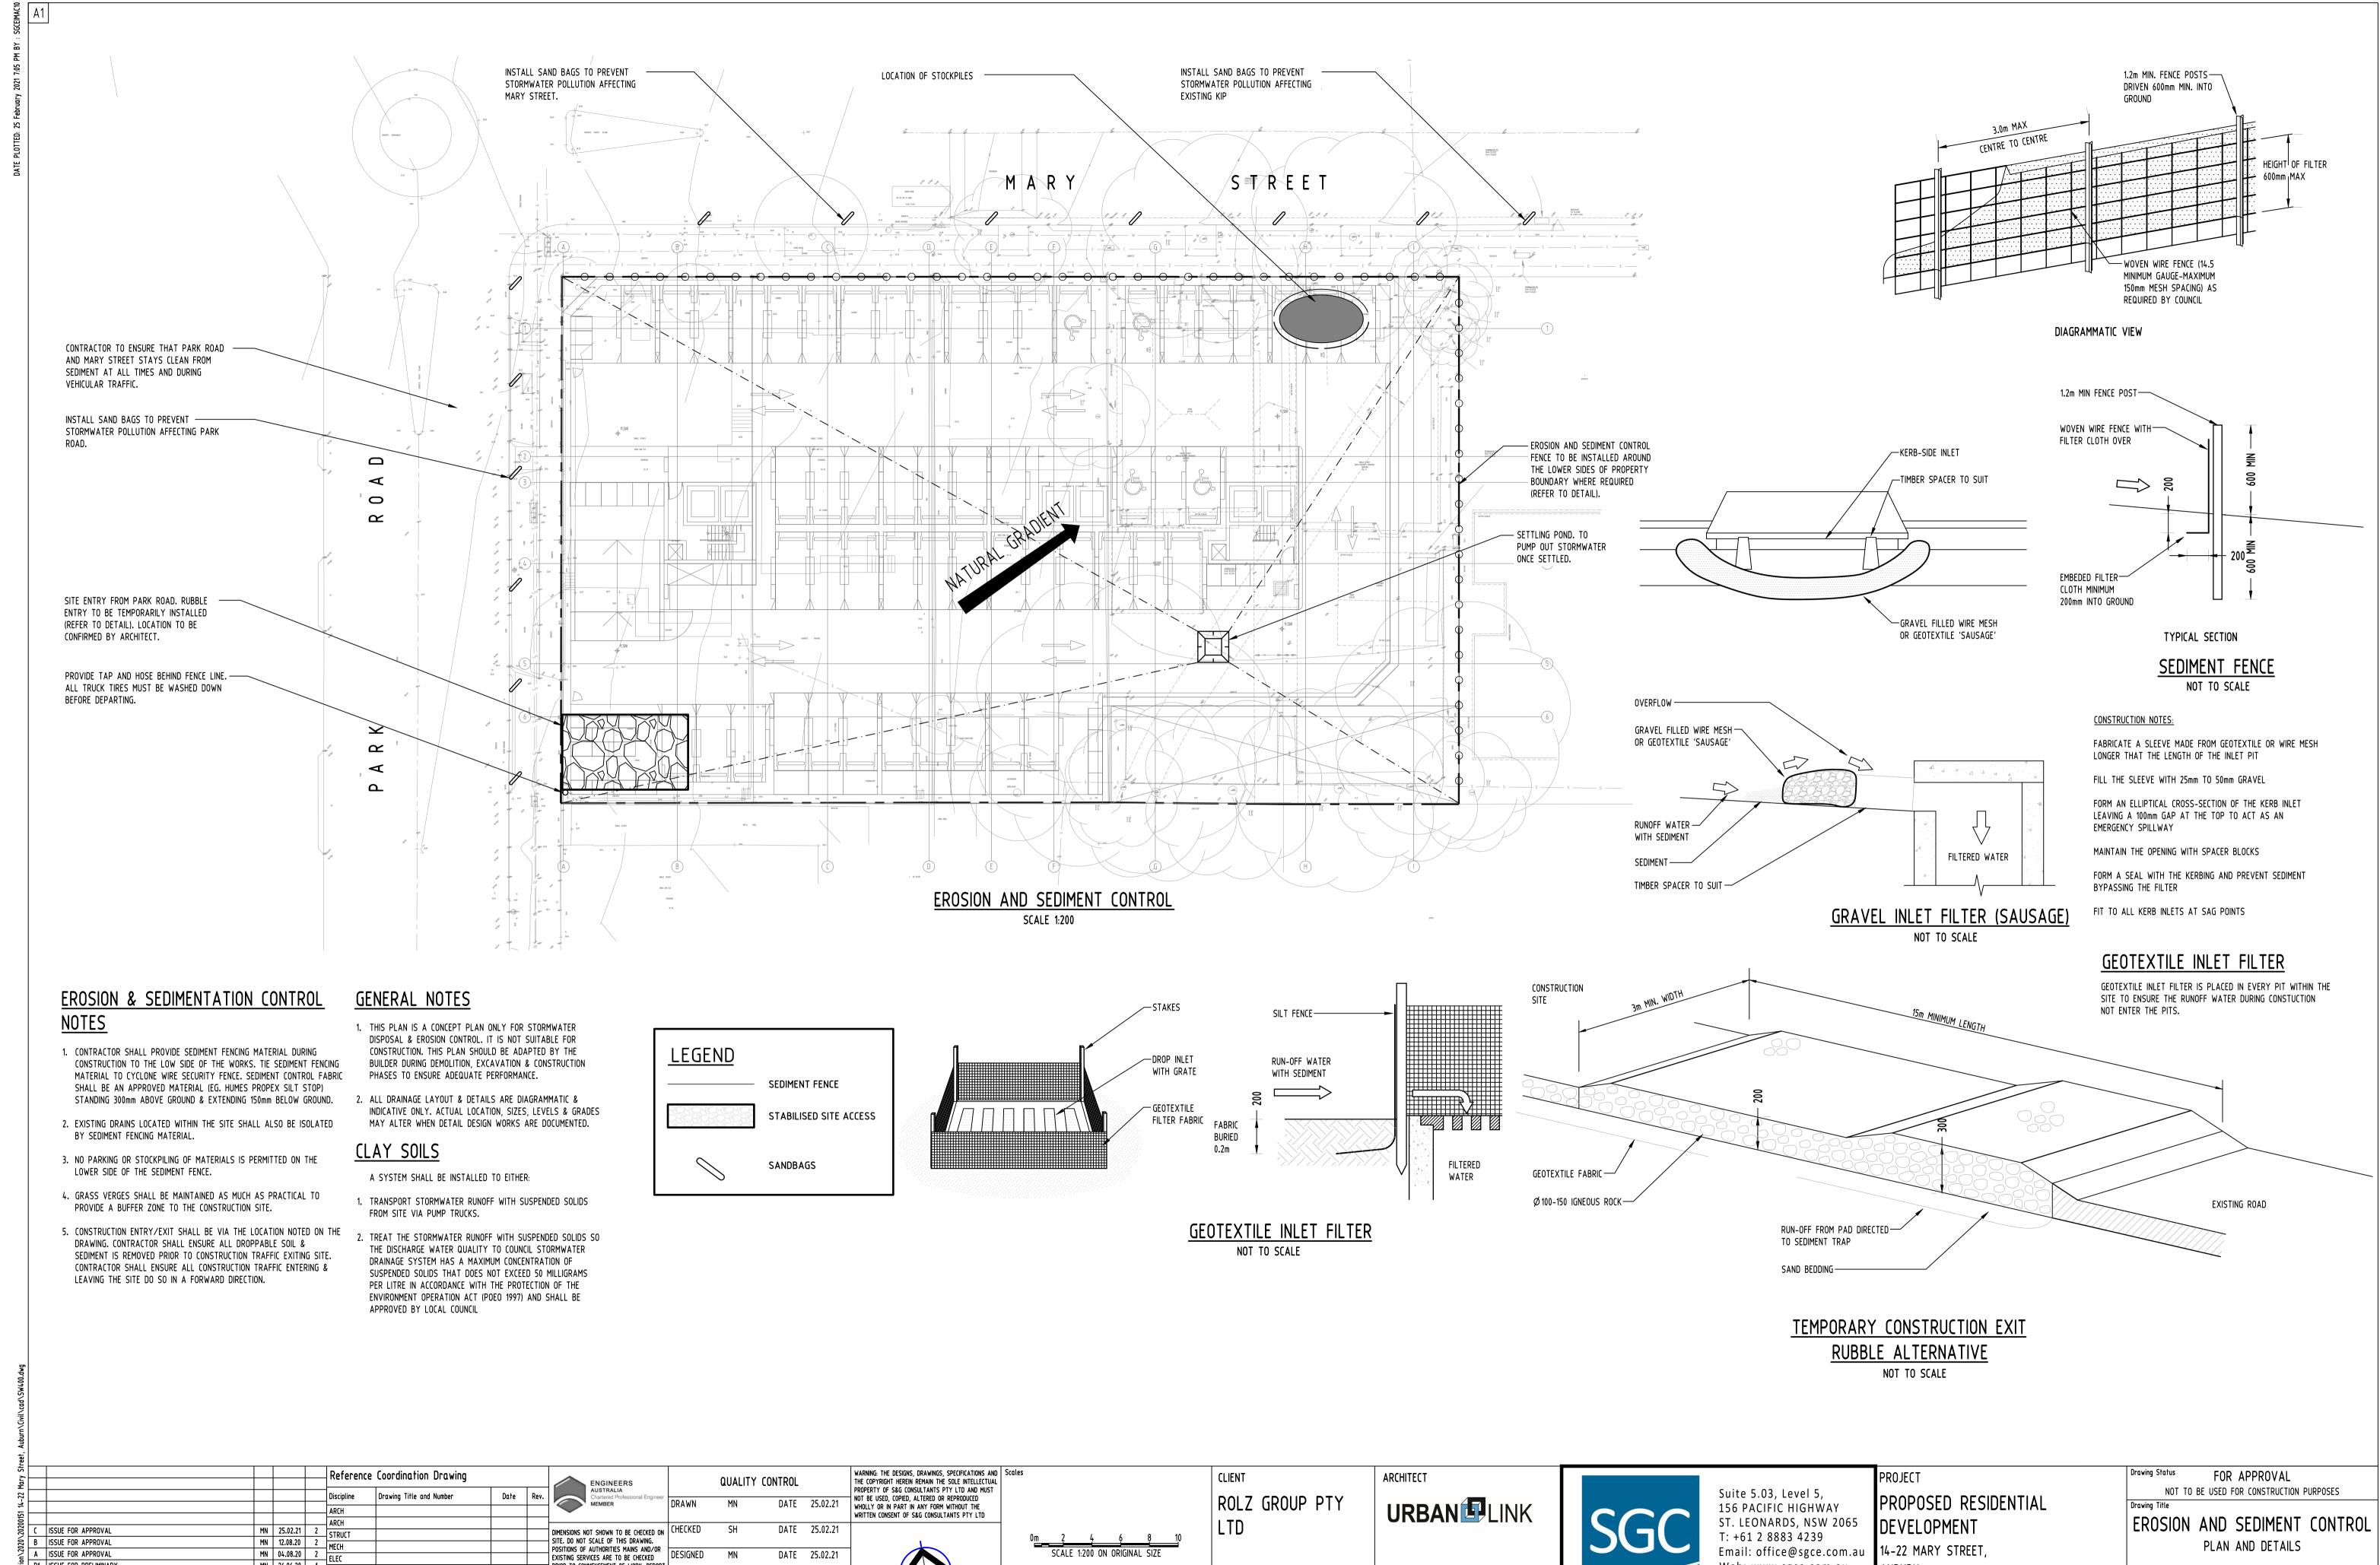

4-tender

B ISSUE FOR APPROVAL A ISSUE FOR APPROVAL P1 ISSUE FOR PRELIMINARY MN 26.06.20 1 HYD by Date Status FIRE Issue Last revision title Issuer internal sequence and revision history 3-construction certificate 2-development application 5-construction 6-other

LANDS

SURVEY

CIVIL

SITE. DO NOT SCALE OF THIS DRAWING. POSITIONS OF AUTHORITIES MAINS AND/OR EXISTING SERVICES ARE TO BE CHECKED PRIOR TO COMMENCEMENT OF WORK, REPORT ANY DISCREPANCIES TO THE CONSULTING ENGINEER FOR DECISION/CLARIFICATION BEFORE PROCEEDING WITH THE WORK, THIS DRAWING IS TO BE READ IN CONJUNCTION WITH THE SPECIFICATIONS AND OTHER CONSULTANTS' DRAWINGS.

DIMENSIONS NOT SHOWN TO BE CHECKED ON CHECKED DESIGNED DATE 25.02.21 APPROVED SH DATE 25.02.21

SCALE 1:200 ON ORIGINAL SIZE



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A.B.N. 21 118 222 530

DEVELOPMENT 14-22 MARY STREET,

AUBURN

8 OF 8

Scale (at original size)

1:200 @ A1

Datum

A.H.D.

PLAN AND DETAILS

Drawing No 20200151